
# UTAH NATIONAL GUARD BRIGHAM CITY ARMORY - BOILER REPLACEMENT

DFCM PROJECT NO. 07182470 BRIGHAM CITY, UTAH



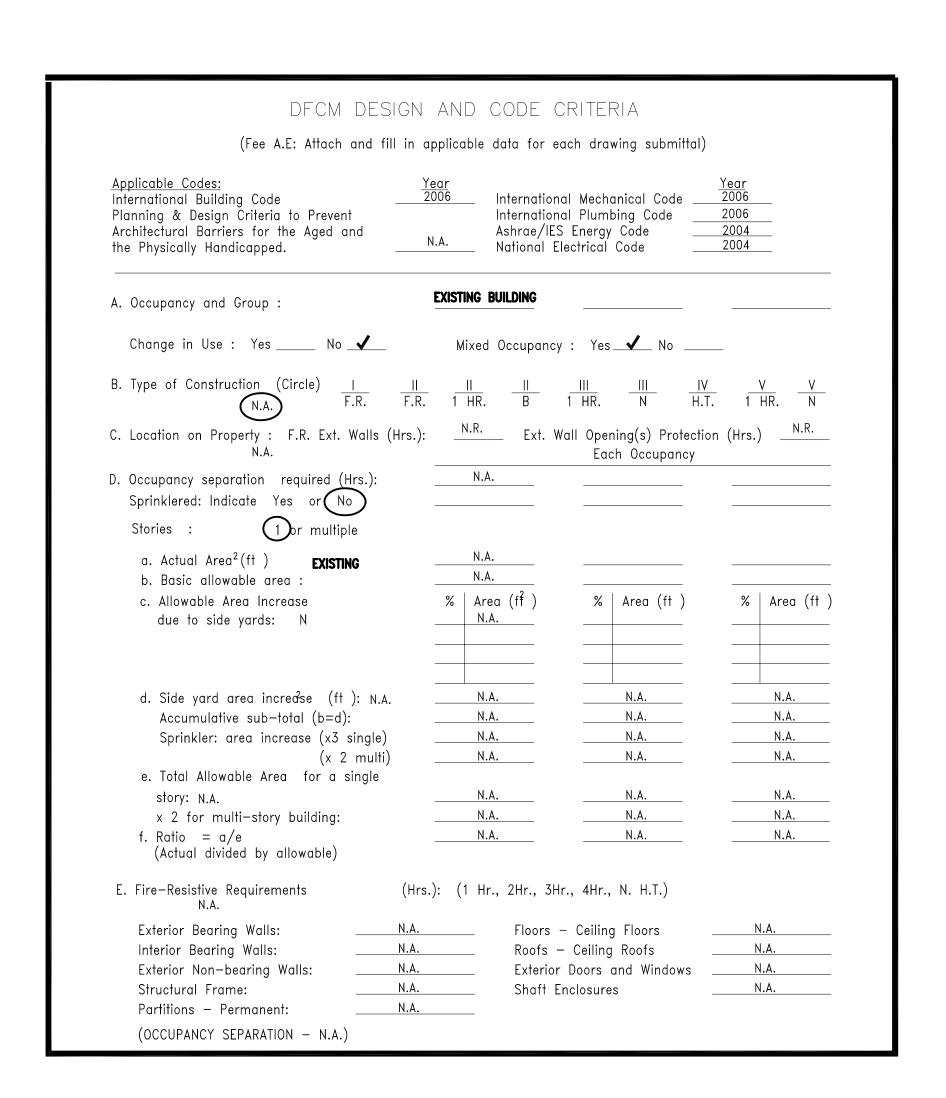

State of Utah—Department of Administrative Services

# DIVISION OF FACILITIES CONSTRUCTION AND MANAGEMENT

4110 State Office Building / Salt Lake City, Utah 84114 / 538-3018

MECHANICAL ENGINEER

WHW ENGINEERING, INC.

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# DRAWING INDEX:

G001 - COVER SHEET

1001 - MECHANICAL GENERAL NOTES & LEGEND

MD401 - LARGE SCALE BOILER ROOM DEMOLITION PLAN

MD402 - MECHANICAL DEMOLITION PHOTO DETAILS

ME401 - LARGE SCALE BOILER ROOM PLAN

ME501 - MECHANICAL DETAILS

ME601 - MECHANICAL SCHEDULES

				ME	CHANICAL LEGEND				
SYMBOL	ABR.	DESCRIPTION	SYMBOL	ABR.	DESCRIPTION	SYMBOL	ABR.	DESCRIPTION	
GENERAL TERMINOLOGY			WET SIDE			WET SIDE CONT			
A		SECTION LETTER DESIGNATION			PUMP	<b>—</b>		PITCH DOWN	
ME-101		- SECTION DRAWN ON THIS SHEET			UNION	0		ELBOW UP	
(12)		- DETAIL NUMBER DESIGNATION	Г		MANUAL ACTUATOR (BALL, BUTTERFLY, NEEDLE, ETC. VALVES)	C		ELBOW DOWN	
A2		CORRESPONDING WITH GRID LOCATION				<del></del>		TEE UP	
AH		MECHANICAL EQUIPMENT DESIGNATION	Т		MANUAL ACTUATOR (GATE, GLOBE,			TEE DOWN	
1		- EQUIPMENT ITEM DESIGNATION			S&D, OS&Y, ETC. VALVES)			EXISTING PIPING TO BE REMOVED	
		GRILLE, OR LOUVER DESIGNATION WHERE	$-\!$		THREADED OR SWEAT VALVE CONNECTION			EXISTING PIPING TO REMAIN	
L-1		BALANCING NOT REQUIRE			FLANGED VALVE CONNECTION			NEW PIPING	
À		REVISION DESIGNATOR AND NUMBER	<b></b> - [		BUTTERFLY VALVE			PIPE CAP OR PLUG	
<u>(1)</u>		KEY NOTE DESIGNATOR AND NUMBER	<b>───</b>		GATE VALVE			CONCENTRIC REDUCER	
•	POC	POINT OF CONNECTION	-7-		CHECK VALVE			ECCENTRIC REDUCER	
$\Theta$	POR	POINT OF REMOVAL	<b>────</b>	PRV	PRESSURE REDUCING VALVE			EXPANSION JOINT	
AFF		ABOVE FINISHED FLOOR	<b>—</b> ₩	CBV	CIRCUIT BALANCING VALVE	—g—		NATURAL GAS PIPING	
٤ EL.		CENTER LINE ELEVATION	—ф—	BV	BALL VALVE	—CF—		CHEMICAL FEED LINE	
GC		GENERAL CONTRACTOR	→ P	PRV	PRESSURE RELIEF VALVE	— ми —		MAKE-UP WATER LINE	
МС		MECHANICAL CONTRACTOR	中		AUTOMATIC AIR VENT		CW	CULINARY COLD WATER	
EC		ELECTRICAL CONTRACTOR			MANUAL AIR VENT	— D —		EQUIPMENT DRAIN	
NIC		NOT IN CONTRACT	7		STRAINER	-HWS-		HEATING WATER SUPPLY	
NTS		NOT TO SCALE			STRAINER W/ PLUGGED BLOW OFF	-HWR-		HEATING WATER RETURN	
SYMBOL	ABR.	DESCRIPTION		VTI	VENTURI				
		EXISTING EQUIPMENT TO BE REMOVED	0		PRESSURE GAUGE AND GAUGE COCK -				
		EXISTING EQUIPMENT TO REMAIN			WATER				
		NEW EQUIPMENT	шишишиш		THERMOMETER AND THERMOWELL				
				TW	THERMOWELL				
			-		DIRECTION OF FLOW				

### **GENERAL NOTES:**

MECHANICAL INFORMATION IS NOT LIMITED TO THE MECHANICAL DRAWINGS. CONTRACTOR SHALL BE RESPONSIBLE FOR EXISTING CONDITIONS AND ANY OBSTRUCTIONS THAT COULD EFFECT THE CONTRUCTION SCOPE.

> A - EACH DRAWING SHEET AND THE SPECIFICATIONS HAVE BEEN PREPARED TO SUPPLEMENT EACH OTHER AND THEY SHALL BE INTERPRETED AS AN INTEGRAL UNIT WITH ITEMS SHOWN AND NOTED ON ONE AND NOT THE OTHER BEING FURNISHED AND INSTALLED AS THOUGH SHOWN AND CALLED OUT IN ALL PLACES. ITEMS IN SPECIFICATIONS OR DRAWINGS LISTED WHICH ARE DIFFERING IN EFFICIENCY OR QUALITY SHALL BE HELD TO THE GREATEST OF: EFFICIENCY, QUALITY OR GOVERNING CODE.

B - THE CONTRACTOR SHALL BE HELD RESPONSIBLE FOR THE INSTALLATION OF THE SYSTEMS ACCORDING TO THE TRUE INTENT AND MEANING OF THE CONTRACT DOCUMENTS.


C - THE CONTRACTOR SHALL INSTALL ALL EQUIPMENT WITH PROPER SERVICE ACCESS AND CLEARANCES ACCORDING TO MANUFACTURERS RECOMMENDATIONS. THE CONTRACTOR SHALL REVIEW SUPPLIERS BID PACKAGES FOR COMPLETENESS AND COMPLIANCE TO THE SPECIFICATIONS, SCHEDULES, AND DESIGN INTENT (ALL EQUIPMENT AND METHODS). THE CONTRACTOR SHALL REMOVE AND REINSTALL CORRECTLY AT HIS OWN EXPENSE ANY EQUIPMENT NOT IN COMPLIANCE.


D - THE CONTRACTOR SHALL CONSULT MANUFACTURERS INSTALLATION INSTRUCTIONS FOR SIZES, METHODS, ACCESSORIES, AND CLEARANCES IN SPACE AVAILABLE PRIOR TO BIDDING PROJECT.

E - ANYTHING NOT CLEAR OR IN CONFLICT WILL BE EXPLAINED BY MAKING APPLICATION TO THE ENGINEER IN WRITING.

- ANY AND ALL ALTERATIONS TO THE SYSTEM SHOWN SHALL BE SUBMITTED TO THE ARCHITECT OR ENGINEER FOR APPROVAL. CONTRACTOR SHALL BE NOTIFIED IN WRITING PRIOR TO ANY CHANGES.
- G-3 CONTRACTOR SHALL FIELD VERIFY ALL DIMENSIONS AND LOCATIONS.
- THE WORKING DRAWINGS ARE DIAGRAMMATIC. THEY DO NOT SHOW EVERY OFFSET, BEND, OR ELBOW NECESSARY FOR THE COMPLETE INSTALLATION IN THE SPACE PROVIDED. ALL LOCATIONS FOR MECHANICAL EQUIPMENT SHALL BE FIELD VERIFIED AND COORDINATED WITH ALL DRAWINGS.
- THE INSTRUCTION TO "PROVIDE" ALSO INCLUDES INSTALLATION.
- SUPPLIERS SHALL REVIEW ALL DRAWINGS AND THE SPECIFICATIONS PRIOR TO SUBMITTING PRICES TO THE CONTRACTOR. ALL QUESTIONS AND DISCREPANCIES SHALL BE BROUGHT TO THE ENGINEERS ATTENTION PRIOR TO BIDDING.
- CONTRACTOR SHALL THOROUGHLY REVIEW AND SIGN SUBMITTALS FOR COMPLETENESS AND COMPLIANCE TO THE SPECIFICATIONS PRIOR TO ENGINEERS REVIEW. SUPPLIERS SHALL HIGHLIGHT OR MARK ALL INFORMATION REQUIRED TO SHOW COMPLIANCE TO THE SPECIFICATIONS. ALL REQUESTED EXCEPTIONS TO THE SPECIFICATIONS, OR SCHEDULES SHALL BE CLEARLY NOTED AND EXPLAINED. SUBMITTAL REVIEW AND ACCEPTANCE IS FOR DESIGN CONCEPT ONLY, AND DOES NOT AT ANY TIME RELIEVE THE CONTRACTOR OF RESPONSIBILITY TO MEET SPECIFICATIONS, CAPACITIES, OR DESIGN INTENT.
- ALL MECHANICAL SHALL BE INSTALLED AND CONFORM TO THE 2006 EDITION OF THE IMC AND IPC WITH UTAH ANNOTATIONS AND LOCAL **AUTHORITY REQUIREMENTS.**
- THIS CONTRACTOR SHALL BE RESPONSIBLE FOR THE DRAINING DOWN AND RE-FILLING OF ALL SYSTEMS NECESSARY TO COMPLETE THE WORK OUTLINED BY THIS PROJECT. THIS INCLUDES PROVIDING THE REQUIRED CHEMICAL TREATMENT WHEN RE-FILLING THE SYSTEM.
- CONTRACTOR SHALL CONTRACT WITH A DESIGN BUILD ELECTRICAL CONTRACTOR TO PROVIDE ALL THE ELECTRICAL AND CONTROLS WORK REQUIRED BY SCOPE OF WORK.

### State of Utah Department of Administrative Services

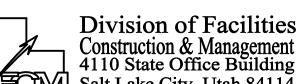

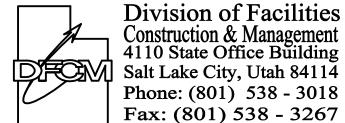

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**CONSULTANTS** 



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PROJECT NAME & ADDRESS

**UTAH NATIONAL GUARD BRIGHAM CITY ARMORY-BOILER** REPLACEMENT

**DFCM No. 07182470** 

Brigham City, Utah

MARK	DATE	REVISION

06/29/07

/WINWARD M


PROJECT MANAGER: SW DRAWN BY: LGD CHECKED BY:

06/29/07 WHW JOB NO.: 07030

SHEET TITLE

**MECHANICAL GENERAL NOTES AND LEGEND** 

**M001** 

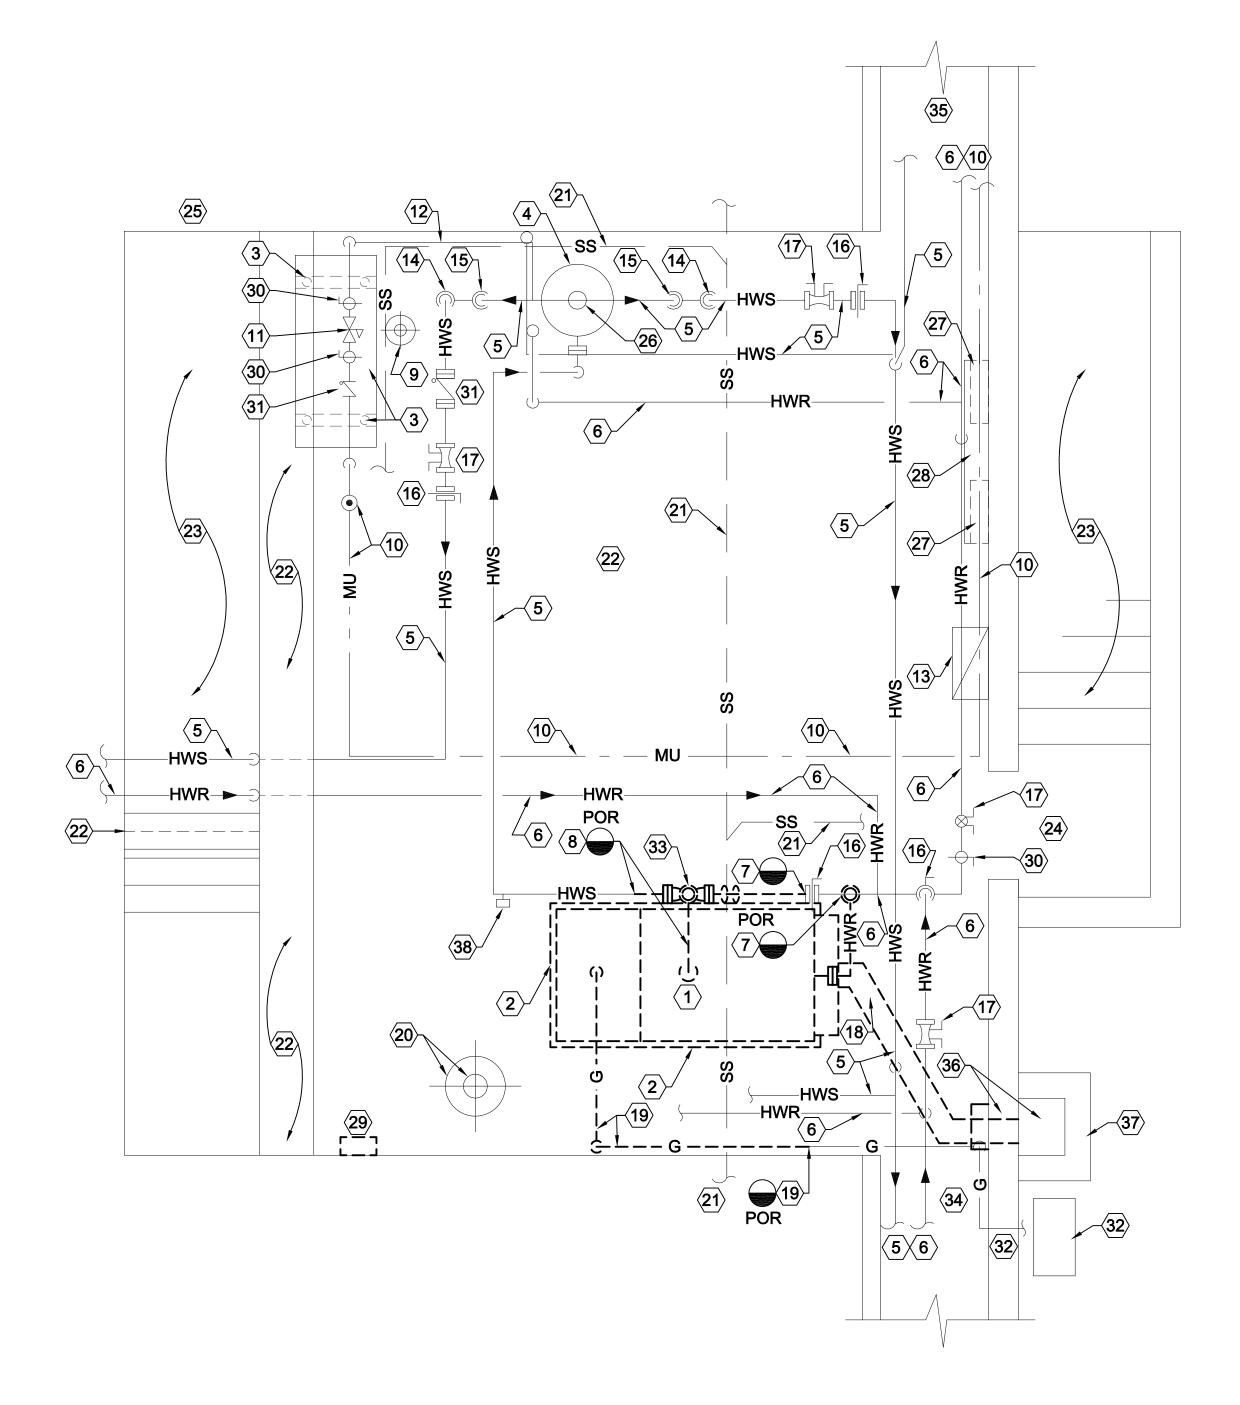

LARGE SCALE BOILER ROOM DEMOLITION PLAN




# SHEET NOTES

### SHEET NOTES:

- $\langle$  1 angleREMOVE EXISTING GAS FIRED HOT WATER BOILER AND ALL ASSOCIATED CONNECTIONS, ELECTRICAL BURNER, CONTROLS ETC.
- (2) REMOVE EXISTING 7'-7" LONG x 4'-0" x 4" THICK CONCRETE PAD.
- (3) EXISTING HORIZONTAL COMPRESSION TANK AND SUPPORTS SHALL REMAIN.
- $\langle$  4  $\rangle$ EXISTING AIR ELIMINATOR SHALL REMAIN.
- (5) EXISTING HOT WATER SUPPLY PIPING SHALL
- $\langle$  6 angleEXISTING HOT WATER RETURN PIPING SHALL REMAIN.
- 7 REMOVE EXISTING HOT WATER RETURN PIPING FROM BOILER CONNECTION BACK TO MAIN. PROVIDE PIPING CAP AT CONNECTION TO MAIN.
- (8) REMOVE EXISTING HOT WATER SUPPLY FROM THIS POINT BACK TO BOILER.
- $\langle 9 \rangle$ EXISTING POT FEEDER AND PIPING SHALL REMAIN.
- (10) EXISTING CULINARY WATER MAKE-UP LINE COMPLETE WITH BACKFLOW PREVENTOR SHALL REMAIN.
- (11) HEATING HOT WATER SYSTEM MAKE-UP WATER C/W CHECK VALVE, BALL VALVES, PRV VALVE ETC. SHALL REMAIN.
- (12) AIR LINE RELIEF FROM AIR FITTING ON AIR ELIMINATOR TO COMPRESSION TANK SHALL REMAIN.
- (13)EXISTING COMBUSTION AIR SHALL BE RENOVATED TO MEET CODE. SEE SHEET ME101.
- (14)EXISTING INLINE HEATING HOT WATER SUPPLY PUMP SHALL REMAIN. PUMPS ARE LOCATED IN VERTICAL PIPE RISER.
- 15 EXISTING BUTTERFLY VALVE AND STRAINER LOCATED IN THE VERTICAL DROP SHALL REMAIN.
- (16)EXISTING BUTTERFLY VALVE SHALL REMAIN. CONTRACTOR HAS CHOICE TO REMOVE VALVE AT HWR MAIN NEAR BOILER OR LEAVE FOR ISOLATION.
- $\langle 17 
  angle$ EXISTING BALANCING VALVE SHALL REMAIN.
- $\langle$ 18 $\rangle$ REMOVE EXISTING BOILER STACK HANGERS, SUPPORTS, ETC.
- 19 REMOVE EXISTING GAS PIPING FROM REMOVED BURNER TO THIS POINT. REMAINDER OF GAS PIPING SHALL REMAIN.
- 20 EXISTING SUMP AND PUMP SHALL REMAIN INCLUDING ALL PIPING VALVES ETC.
- (21) EXISTING OVERHEAD SEWER PIPING SHALL
- (22) EXISTING OVERHEAD CONCRETE BEAMS.
- (23) EXISTING STAIRS.
- (24) ACCESS DOOR FROM OUTSIDE.
- (25) ACCESS DOOR FROM INTERIOR.
- (26) AIR SEPARATOR FITTING ON TOP OF TANK SHALL REMAIN.
- (27) EXISTING ELECTRICAL PANELS SHALL REMAIN.
- $\langle 28 \rangle$ EXISTING BUSS DUCT SHALL REMAIN.
- (29) REMOVE EXISTING BOILER CONTROL PANEL. ÉLECTRICAL SHALL REMAIN FOR NEW PANEL.
- $|\langle 30 \rangle$ BALL VALVES SHALL REMAIN.
- ⟨31⟩CHECK VALVES SHALL REMAIN.
- (32) EXISTING GAS LINE THROUGH EXTERIOR WALL TO \_  $^{-}$  AND INCLUDING GAS METER SHALL REMAIN.
- (33) REMOVE EXISTING 3-WAY CONTROL VALVE. RE-USE FOR NEW SYSTEM IN LOCATION SHOWN ON SHEET ME401.
- (34) EXISTING SOUTH TUNNEL ENTRANCE FROM BOILER ROOM.
- (35)EXISTING NORTH TUNNEL ENTRANCE FROM BOILER ROOM.
- (36) EXISTING CHIMNEY ENTRANCE SHALL BE REMOVED AND CONCRETE WALL PATCHED. FIELD VERIFY IF EXISTING BOILER BREECHING IS CONTINUOUS UP TO THE TOP OF CHIMNEY. IF SO, CONTRACTOR SHALL REMOVE BREECHING FROM INSIDE CHIMNEY.
- (37) EXISTING CHIMNEY SHALL REMAIN.
- (38) TEMPERATURE CONTROLLER SHALL REMAIN.

### State of Utah Department of Administrative Services



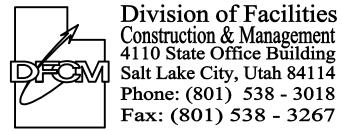

Internet: http://www.dfcm.state.ut.us

### **CONSULTANTS**



PROJECT NAME & ADDRESS

# **UTAH NATIONAL GUARD BRIGHAM CITY ARMORY-BOILER** REPLACEMENT

# **DFCM No. 07182470**

Brigham City, Utah

MARK	DATE	REVISION


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PROJECT MANAGER: SW DRAWN BY: LGD CHECKED BY:


06/29/07 WHW JOB NO.: 07030

LARGE SCALE BOILER **ROOM DEMOLITION PLAN** 

**MD401** 

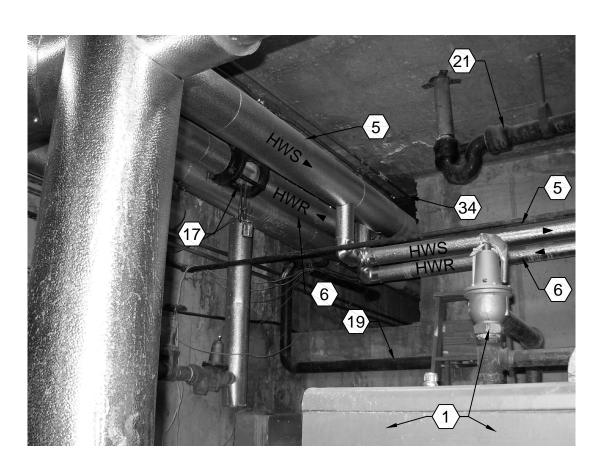


SOUTH TUNNEL ENTRANCE

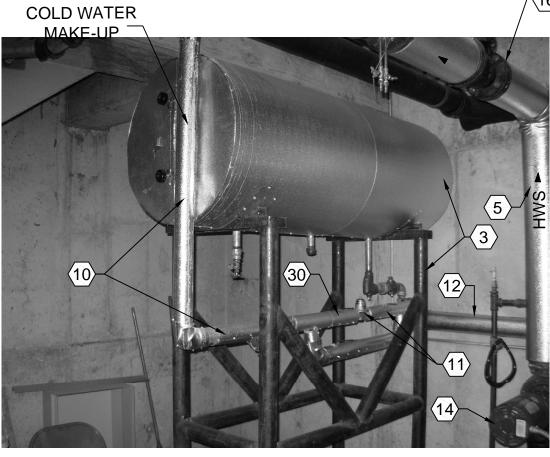


COMPRESSION **TANK & MAKE-UP** 




**EXISTING BOILER CONTROL PANEL** 

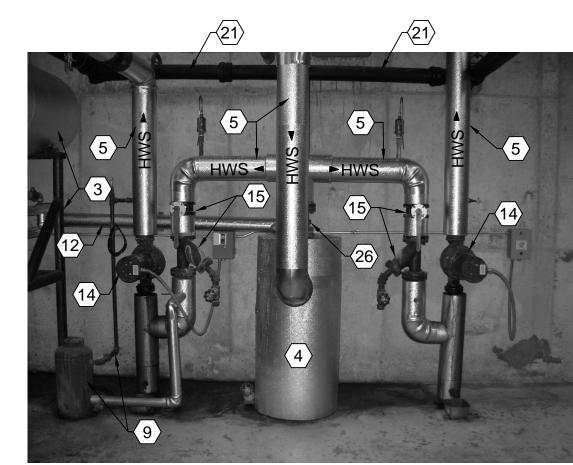


**HWS HEADER** 

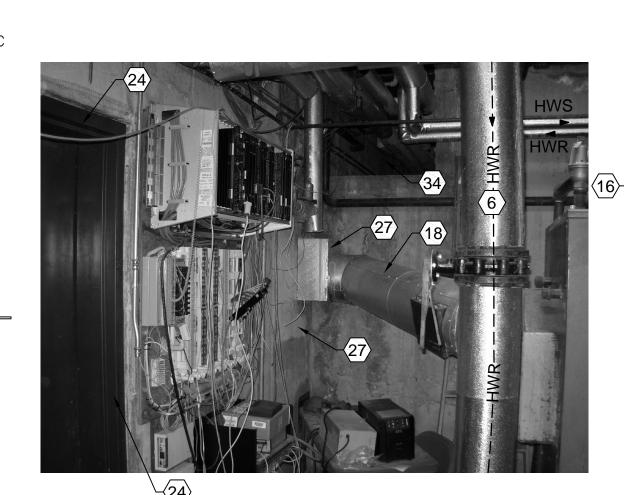


**BOILER STACK/** CHIMNEY ENTRANCE SCALE: NONE

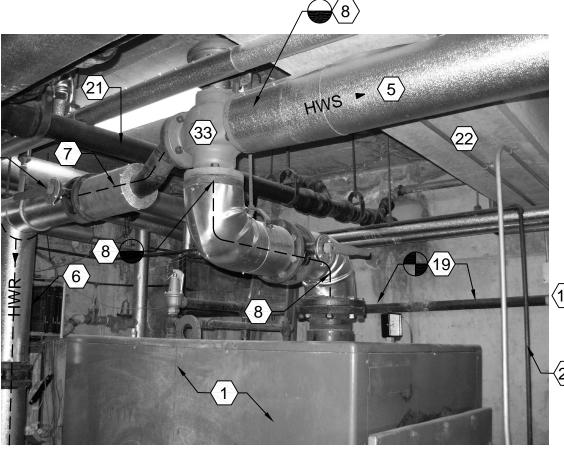


HWS HEADER

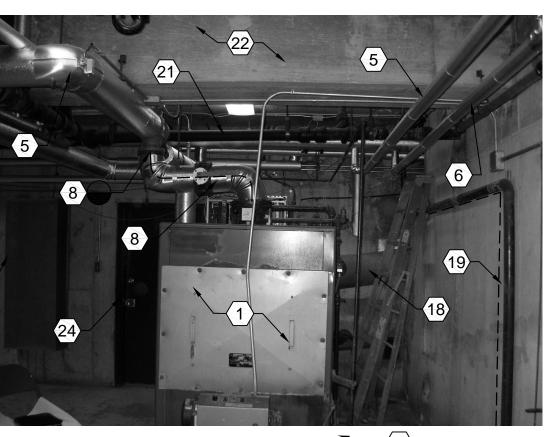


**EXISTING BOILER DEMOLITION** SCALE: NONE

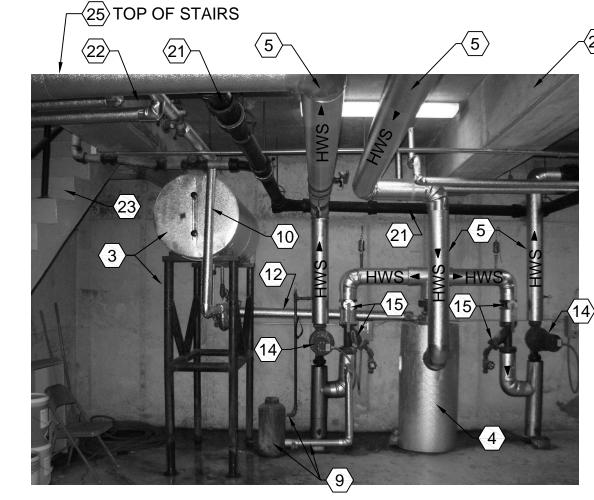


HWS COMPRESSON TANK, MAKE-UP, PUMP & AIR ELIMINATOR SCALE: NONE

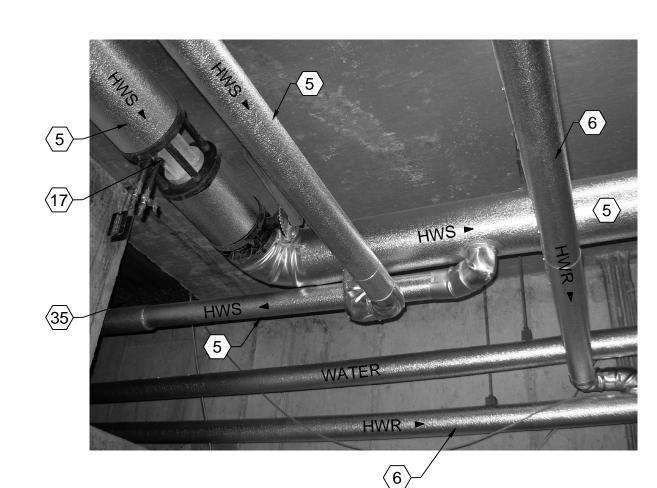



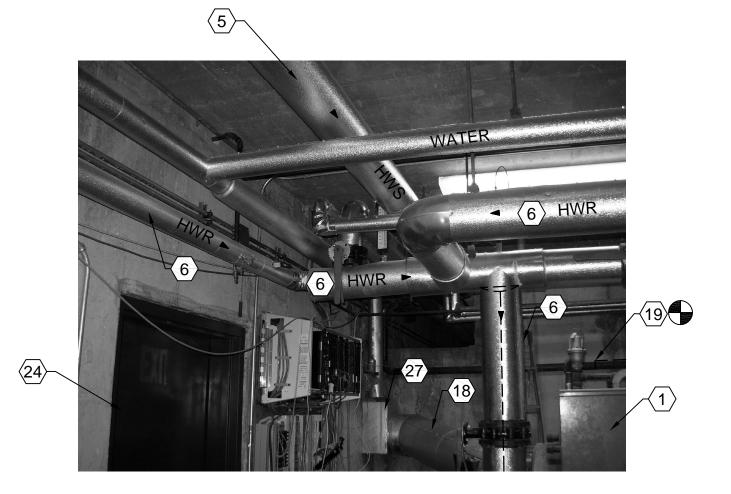

HWR HEADER SCALE: NONE

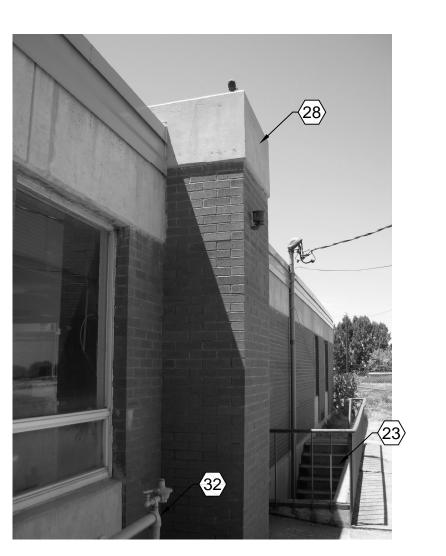

**EXTERIOR GAS** METER AND CHIMNEY

# SHEET NOTES

1 REMOVE EXISTING GAS FIRED HOT WATER BOILER AND ALL ASSOCIATED CONNECTIONS, ELECTRICAL, BURNER, CONTROLS ETC.

SHEET NOTES:

- 2 REMOVE EXISTING 7'-7" LONG x 4'-0" x 4" THICK CONCRETE PAD.
- (3) EXISTING HORIZONTAL COMPRESSION TANK AND SUPPORTS SHALL REMAIN.
- 4 EXISTING AIR ELIMINATOR SHALL REMAIN.
- (5) EXISTING HOT WATER SUPPLY PIPING SHALL REMAIN.
- (6) EXISTING HOT WATER RETURN PIPING SHALL REMAIN.
- (7) REMOVE EXISTING HOT WATER RETURN PIPING FROM BOILER CONNECTION BACK TO MAIN. PROVIDE PIPING CAP AT CONNECTION TO MAIN.
- 8 REMOVE EXISTING HOT WATER SUPPLY FROM THIS POINT BACK TO BOILER.
- 9 EXISTING POT FEEDER AND PIPING SHALL REMAIN.
- (10) EXISTING CULINARY WATER MAKE-UP LINE COMPLETE WITH BACKFLOW PREVENTOR SHALL REMAIN.
- (11) HEATING HOT WATER SYSTEM MAKE-UP WATER C/W CHECK VALVE, BALL VALVES, PRV VALVE ETC. SHALL REMAIN.
- (12) AIR LINE RELIEF FROM AIR FITTING ON AIR ELIMINATOR TO COMPRESSION TANK SHALL REMAIN.
- (13) EXISTING COMBUSTION AIR SHALL BE RENOVATED TO MEET CODE. SEE SHEET ME101.
- (14) EXISTING INLINE HEATING HOT WATER SUPPLY PUMP SHALL REMAIN.
- (15) EXISTING BUTTERFLY VALVE AND STRAINER SHALL REMAIN.
- (16) EXISTING BUTTERFLY VALVE SHALL REMAIN OR BE REMOVED. CHOICE IS UP TO THE CONTRACTOR.
- (17) EXISTING BALANCING VALVE SHALL
- (18) REMOVE EXISTING BOILER STACK HANGERS, SUPPORTS, ETC.
- (19) REMOVE EXISTING GAS PIPING FROM REMOVED BURNER TO THIS POINT. REMAINDER OF GAS PIPING SHALL REMAIN.
- (20) EXISTING SUMP AND PUMP SHALL REMAIN INCLUDING ALL PIPING VALVES
- (21) EXISTING OVERHEAD SEWER PIPING
- SHALL REMAIN. 22 EXISTING OVERHEAD CONCRETE
- 23 EXISTING STAIRS.
- 24 ACCESS DOOR FROM OUTSIDE.
- 25 ACCESS DOOR FROM INTERIOR.
- 26 AIR SEPARATOR FITTING ON TOP OF TANK SHALL REMAIN.
- 27 EXISTING CHIMNEY ENTRANCE SHALL BE REMOVED AND CONCRETE WALL PATCHED. FIELD VERIFY IF EXISTING BOILER BREECHING IS CONTINUOUS UP TO THE TOP OF CHIMNEY. IF SO, CONTRACTOR SHALL REMOVE BREECHING FROM INSIDE CHIMNEY.
- 28 EXISTING CHIMNEY SHALL REMAIN.
- 29 REMOVE EXISTING BOILER CONTROL PANEL. ELECTRICAL SHALL REMAIN FOR NEW PANEL.
- 30 BALL VALVES SHALL REMAIN.
- (31) CHECK VALVES SHALL REMAIN.
- (32) EXISTING GAS LINE THROUGH EXTERIOR WALL TO AND INCLUDING GAS METER SHALL REMAIN.
- 33 REMOVE EXISTING 3-WAY CONTROL VALVE AND SET ASIDE FOR REINSTALLATION INTO NEW PIPING.
- 34 EXISTING SOUTH TUNNEL ENTRANCE FROM BOILER ROOM.
- 35 EXISTING NORTH TUNNEL ENTRANCE FROM BOILER ROOM.

State of Utah

Department of Administrative Services

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**WHW** 

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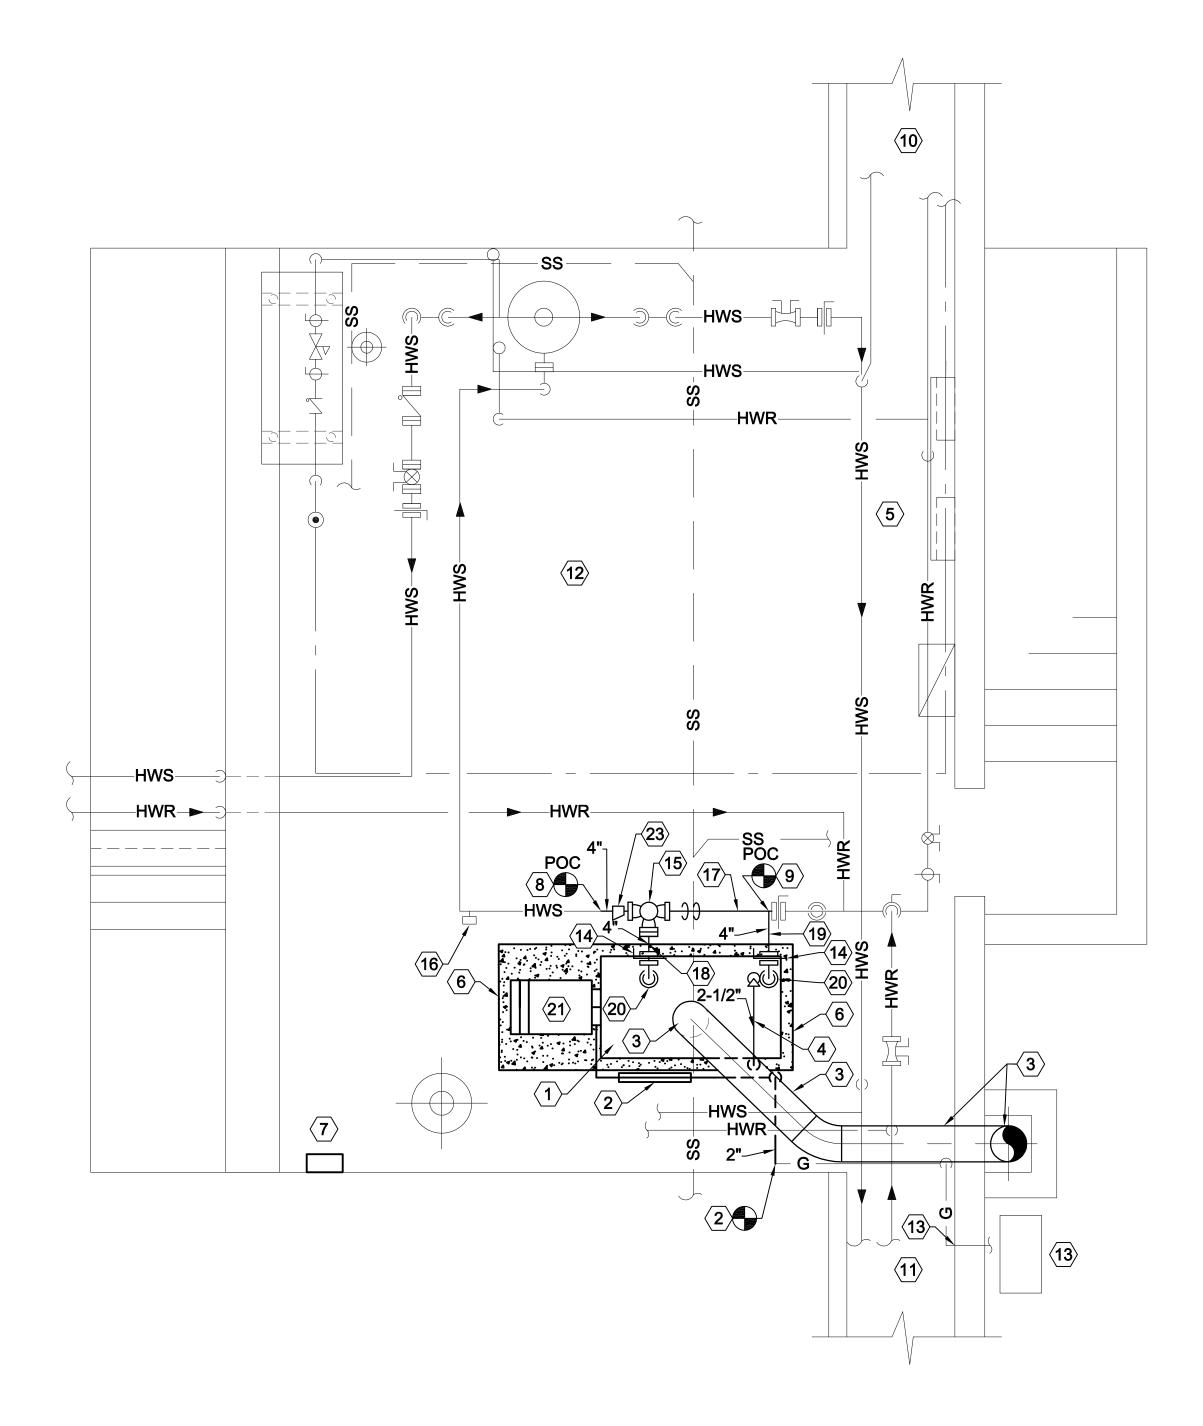
MARK DATE REVISION

PROJECT MANAGER: SW DRAWN BY: LGD 'WINWARD M CHECKED BY: 06/29/07 WHW JOB NO.:

07030 SHEET TITLE

**MECHANICAL DEMOLITION PHOTO-DETAILS** 

**MD402** 



LARGE SCALE BOILER ROOM FLOOR PLAN



SHEET NOTES

### SHEET NOTES:

- (1) PROVIDE NEW GAS FIRED HOT WATER BOILER AND CONNECT TO EXISTING PIPING AS SHOWN.
- 2 PROVIDE NEW 2" GAS PIPING FROM THIS POINT TO NEW CSD-1 GAS TRAIN SEE DETAIL A4/ME501.
- (3) PROVIDE NEW 12" BOILER BREECHING FROM NEW BOILER TO EXISTING CHIMNEY WALL. DRILL THROUGH WALL AND EXTEND NEW BREECHING INSIDE EXISTING CHIMNEY AND RISE UP TO TOP OF CHIMNEY. SUPPORT **BREECHING AS REQUIRED BY** BREECHING MANUFACTURER.
- (4) ROUTE 2" RELIEF PIPING FROM BOILER PRESSURE RELIEF VALVE TO FLOOR. PROVIDE ONLY ONE 90° ELL IN DISCHARGE PIPING.
- 5 THIS CONTRACTOR SHALL EMPLOY A DESIGN BUILD ELECTRICAL CONTRACTOR FOR ALL ELECTRICAL WORK.
- 6 PROVIDE NEW CONCRETE PAD. EXTEND PAD A MINIMUM OF 4" BEYOND BOILER AND BURNER ALL SIDES. SEE DETAIL D4/ME501.
- (7) PROVIDE NEW BOILER CONTROL PANEL IN SAME LOCATION AS REMOVED PANEL. CONNECT TO NEW BURNER AND BOILER CONTROLS.
- (8) CONNECT TO EXISTING HOT WATER SUPPLY PIPING AT THIS LOCATION. FIELD VERIFY EXACT LOCATION FOR TIE-IN.
- (9) CONNECT TO EXISTING HOT WATER RETURN PIPING AT THIS LOCATION. FIELD VERIFY EXACT LOCATION FOR TIE-IN.
- NORTH TUNNEL ENTRANCE FROM BOILER ROOM. SEE A1/MD402.
- (11) SOUTH TUNNEL ENTRANCE FROM BOILER ROOM. SEE C1/MD402.
- (12) SEE MD401 & MD402 FOR ITEMS THAT ARE TO BE REMOVED AND ITEMS TO
- (13) EXISTING GAS METER AND GAS LINE THROUGH EXTERIOR WALL SHALL
- NEW 4" BUTTERFLY VALVE C/W COMPANION 125# FLANGES.
- (15) EXISTING PNEUMATIC 3-WAY CONTROL VALVE, INSTALL IN NEW LOCATION. EXTEND PNEUMATIC TUBING TO CONTROLLER.
- (16) EXISTING TEMPERATURE CONTROLLER SHALL REMAIN. CONNECT TO 3-WAY VALVE AND OUTSIDE SENSOR FOR RESET SCHEDULE.
- ⟨17⟩ NEW 3" HWR PIPING BETWEEN **RELOCATED 3-WAY VALVE AND** EXISTING BUTTERFLY VALVE. PIPING SHALL BE ANGLED DOWN TO AVOID SEWER PIPING.
- (18) NEW 4" HWS PIPING FROM BOILER CONNECTION TO RELOCATED 3-WAY VALVE. SEE DETAIL B1/ME501.
- (19) NEW 4" HWR PIPING FROM BOILER CONNECTION TO NEW CONNECTION AS
- 20 NEW 3" 125# FLANGES AND 4"x3" REDUCER IN BOILER CONNECTION. SEE
- (21) NEW BURNER BY BOILER MANUFACTURER.
- (22) CONTRACTOR SHALL BE RESONSIBLE FOR METHOD OF BRINGING BOILER INTO BOILER ROOM. EXISTING BOILER MAY BE CUT-UP IN ORDER TO FIT THROUGH DOOR. NEW BOILER MAY BE BROKEN DOWN TO FIT THROUGH DOOR. COORDINATE WITH BOILER MANUFACTURER.
- (23) 4"x3" ECCENTRIC REDUCER. FLAT SIDE ON TOP.

## State of Utah Department of Administrative Services



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PROJECT NAME & ADDRESS


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**DFCM No. 07182470** 

Brigham City, Utah

MARK	DATE	REVISION


PROJECT MANAGER: SW DRAWN BY: LGD CHECKED BY: 06/29/07 WHW JOB NO.:

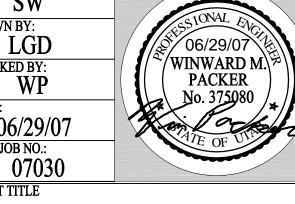

SHEET TITLE

LARGE SCALE BOILER **ROOM PLAN** 

**ME401** 

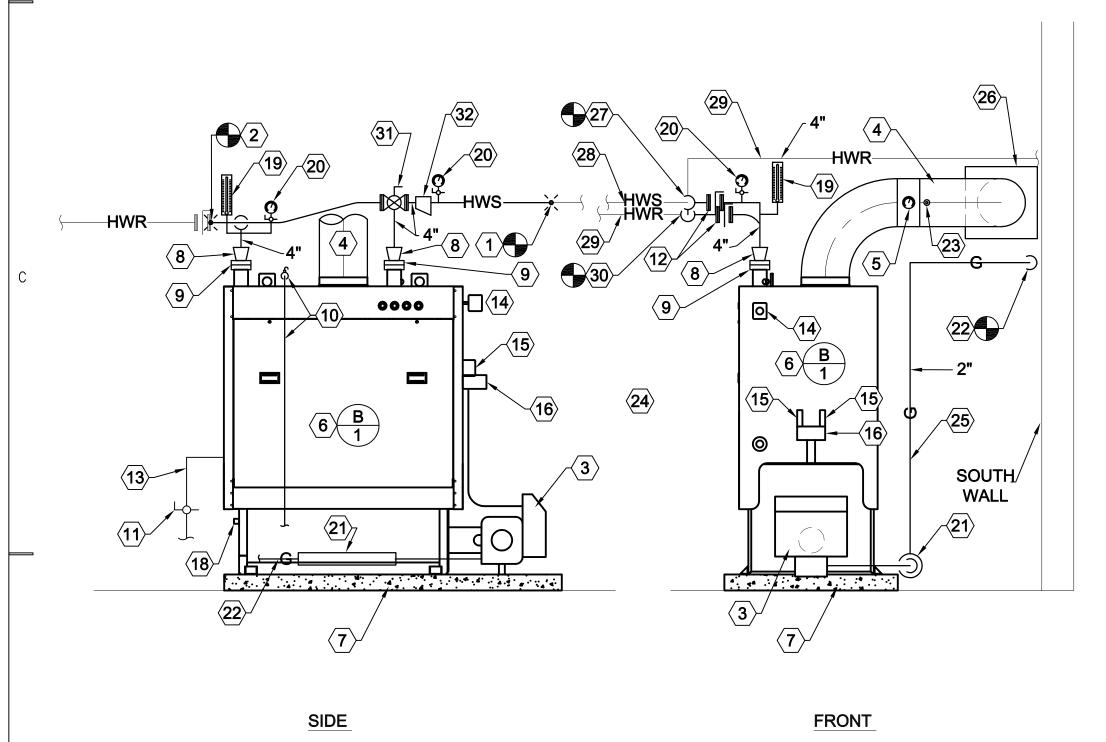

SHEET NOTES:

PIPING. SEE ME101.

TO EXISTING CHIMNEY.

THERMOMETER.

INSTRUCTIONS.

D4/THIS SHEET.

**ABOVE FLOOR** 

(11) BALL VALVE.

FLANGES.

VALVE.

⟨14⟩ PROBE TYPE L.W.C.O.

(16) ELECTRICAL ENCLOSURE.

(18) FLAME OBSERVATION PORT.

(15) AQUASTATS - TWO.

DIAMETER.

A4/THIS SHEET.

SEE SHEET ME101.

NIPPLE AND CAP.

USE PLUGS.

VALVE.

ON TOP.

(25) NEW 2" GAS PIPING.

BOILER CONNECTION.

(1) FIELD CONNECT TO EXISTING HWS

FIELD CONECT TO EXISTING HWR PIPINGS. SEE ME101.

(3) NEW FORCED DRAFT BURNER AND PANEL BY BOILER MANUFACTURER.

(5) PROVIDE STACK THERMOMETER IN

(6) NEW BOILER B-1 SEE SCHEDULE. **INSTALL PER MANUFACTURER'S** 

4 NEW 12"Ø BOILER BREECHING. ROUTE

BOILER BREECHING. USE ROUND

(7) NEW 4" CONCRETE PAD. SEE DETAIL

 $\langle 8 \rangle$  4"x3" CONCENTRIC REDUCER IN RISER.

9 PROVIDE NEW 3" - 125# FLANGES FOR

PROVIDE NEW 2" RELIEF PIPING TO 4"

(12) 4" BUTTERFLY VALVE AND COMPANION

DRAIN LINE SAME SIZE AS BOILER CONNECTION C/W UNION AND BALL

(17) PRESSURE TEMPERATURE GAUGE.

(19) THERMOMETER 0-250° F, 9" LONG.

20 PRESSURE GAUGE 0-100 PSIG WITH

(21) NEW CSD-1 GAS TRAIN. SEE DETAIL

(22) CONNECT TO EXISTING GAS PIPING.

23 PROVIDE 1/2" TEST PORT CAP WITH

ALL BOILER OPENINGS AND

24 PROVIDE NIPPLES AND CAPS TO CLOSE

APPURTANCES NOT USED. DO NOT

26 PROVIDE 20"x20" SHEET METAL PLATE

WALL. SEAL AROUND PLATE.

(28) EXISTING HWS SHALL REMAIN.

(29) EXISTING HWR SHALL REMAIN.

(30) FIELD CONNECT TO EXISTING HWR PIPING. SEE SHEET ME101.

(31) RE-INSTALL EXISTING 3-WAY AUTO

32 4"x3" ECCENTRIC REDUCER FLAT SIDE

\$\langle 27 \rangle FIELD CONNECT TO EXISTING HWS PIPING. SEE SHEET ME101.


AROUND 12" BREECHING. BOLT TO

SNUBBER AND SHUT-OFF VALVE - 4-1/2"


(10) BOILER PROVIDED RELIEF VALVE.

SCALE: 1/2" = 1'-0"


# **BOILER FRONT** AND SIDE ELEVATON AND PIPING DETAIL

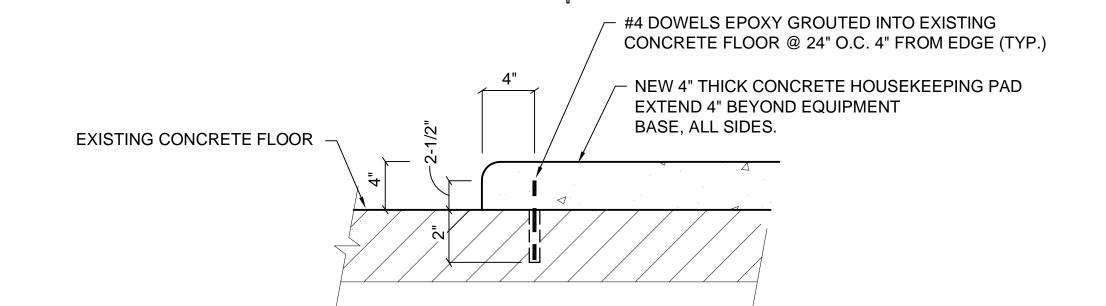

# CONCRETE HOUSEKEEPING PAD

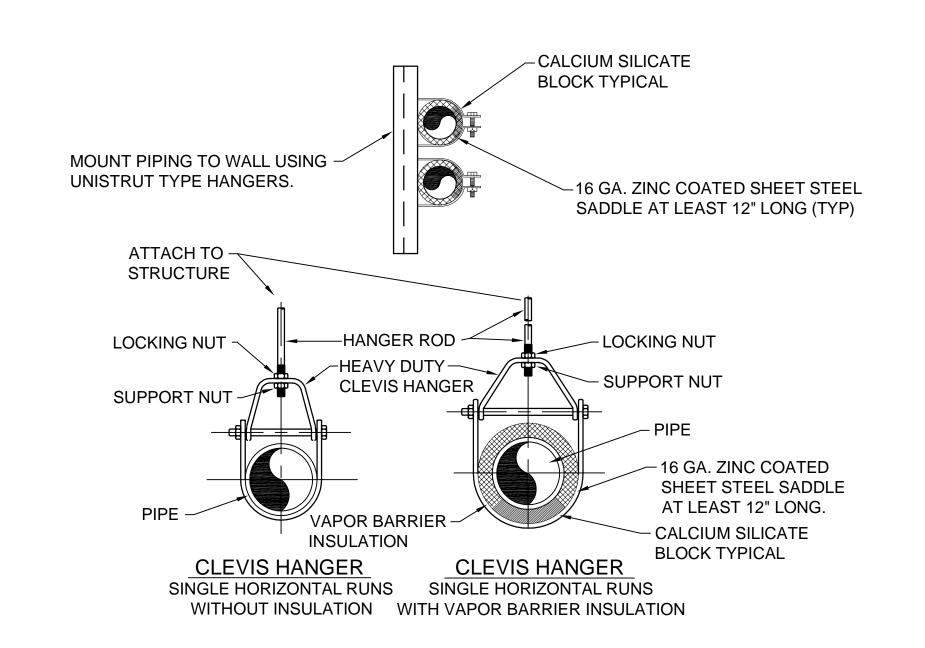



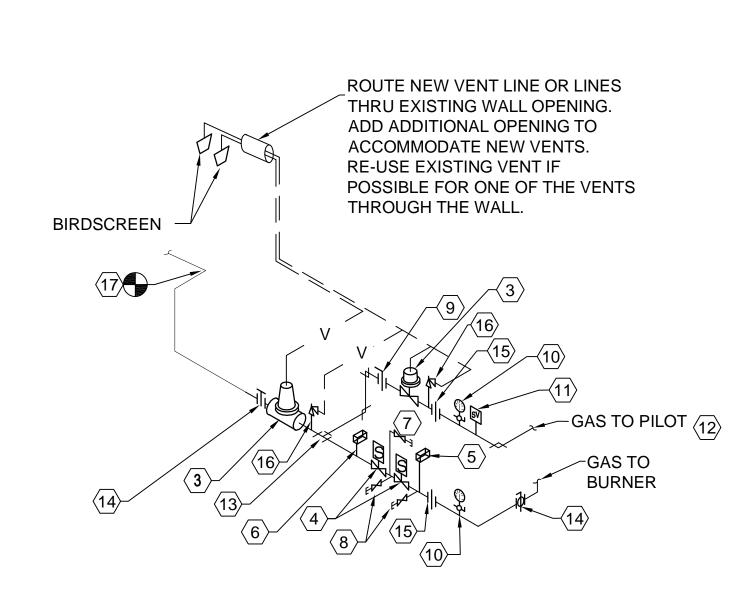

LEGEND							
NO.							
1	GAS INLET						
2	SUPPORT GAS TRAIN FROM PAD OR FLOOR						
3	GAS PRESSURE REGULATOR						
4	MOTORIZED SAFETY VALVE						
5	HIGH PRESSURE SWITCH						
6	LOW PRESSURE SWITCH						
7	VENT VALVE AND VENT						
8	TEST COCK						
9	SHUT-OFF COCK						
10	PRESSURE GUAGE/ SHUT-OFF						
11	SOLENOID VALVE						
12	GAS TO PILOT						
13	GAS TAKE-OFF TO PILOT						
14	SHUT-OFF VALVE						
15	UNION						
16	RELIEF VALVE-VENT TO ATMOSPHERE						
17	CONNECT TO EXISTING GAS LINE THIS LOCATION. SEE SHEET ME401. FIELD VERIFY EXACT LOCATION.						

CSD-1 AUTO-IGNITION GAS TRAIN DETAIL SCALE: NONE

State of Utah Department of Administrative Services

Division of Facilities Construction & Management 4110 State Office Building Salt Lake City, Utah 84114 Phone: (801) 538 - 3018 Fax: (801) 538 - 3267

Internet: http://www.dfcm.state.ut.us

**CONSULTANTS** 



**WHW ENGINEERING INC.** ROFESSIONAL MECHANICAL ENGINEERING 1354 East 3300 South Suite 200 SALT LAKE CITY, UTAH 84106 (801)466-4021, FAX 466-8536

PROJECT NAME & ADDRESS

**UTAH NATIONAL GUARD BRIGHAM CITY ARMORY-BOILER** REPLACEMENT

**DFCM No. 07182470** 

Brigham City, Utah REVISION

MARK DATE

PROJECT MANAGER: SW DRAWN BY: LGD CHECKED BY: 06/29/07

**7**06/29/07 /WINWARD M **PACKER** WHW JOB NO.: 07030 SHEET TITLE


**MECHANICAL DETAILS** 

**ME501** 

BOILER SCHEDULE										
SYMBOL	MBH INPUT	MBH OUTPUT	WATER TEMP		BOILER HP	DELTA P FT	FAN MOTOR	OPERATION WEIGHT LBS	MAKE AND MODEL#	SCHEDULE NOTES
			IN	OUT		Г	MOTOR	WEIGITI EBS	WODEL#	NOTES
B 1	1,500	1.275	160°F	180°F	38			3304	BRYAN HECLM 150	1,2,3,4,5

- 1. BOILER RATINGS ARE FOR SEA LEVEL.
- 2. SEE SPECIFICATION FOR OTHER APPROVED MANUFACTURERS.
- 3. VERIFY FLUE SIZING AND MATERIAL WITH EACH BOILER MANUFACTURER AND INSTALL ACCORDINGLY.
- 4. PROVIDE 120V CONTROL CIRCUIT.
- 5. RELIEF VALVE- ONE (1) 1-1/2"x2 -VERIFY SIZING AND QUANTITY WITH BOILER INSTALL AND INSTALL ACCORDINGLY.

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**MECHANICAL SCHEDULES** 

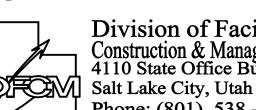**ME601**